

AN ADDENDUM
TO
TENDER NO: KOFC/OT/GEN/008/2020-2021



KENYA ORDNANCE FACTORIES CORPORATION
P.O BOX 6634 – 30100
ELDORET

OPEN TENDER DOCUMENT

FOR

**PROPOSED DESIGN, CONSTRUCTION,
SUPPLY, INSTALLATION, TESTING, TRAINING
AND COMMISSIONING OF GRAIN INTAKE,
CLEANING, DRYING, STORAGE, BULK LOADING
& BAGGING OFF PLANT**


Page 1 of 2

**PROPOSED DESIGN, CONSTRUCTION, SUPPLY, INSTALLATION, TESTING, TRAINING AND
COMMISSIONING OF GRAIN INTAKE, CLEANING, DRYING, STORAGE, BULK LOADING & BAGGING
OFF PLANT**

Date 09th March 2021

1. Kindly insert the attached KOFC Site Plan immediately after Page 51 of the Tender Document.
2. Kindly treat this addendum as part of the tender.
3. Other details remain the same.


Yours faithfully,

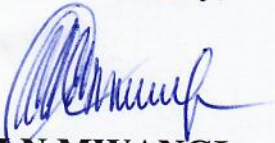

M.N. MWANGI

Colonel

for Managing Director

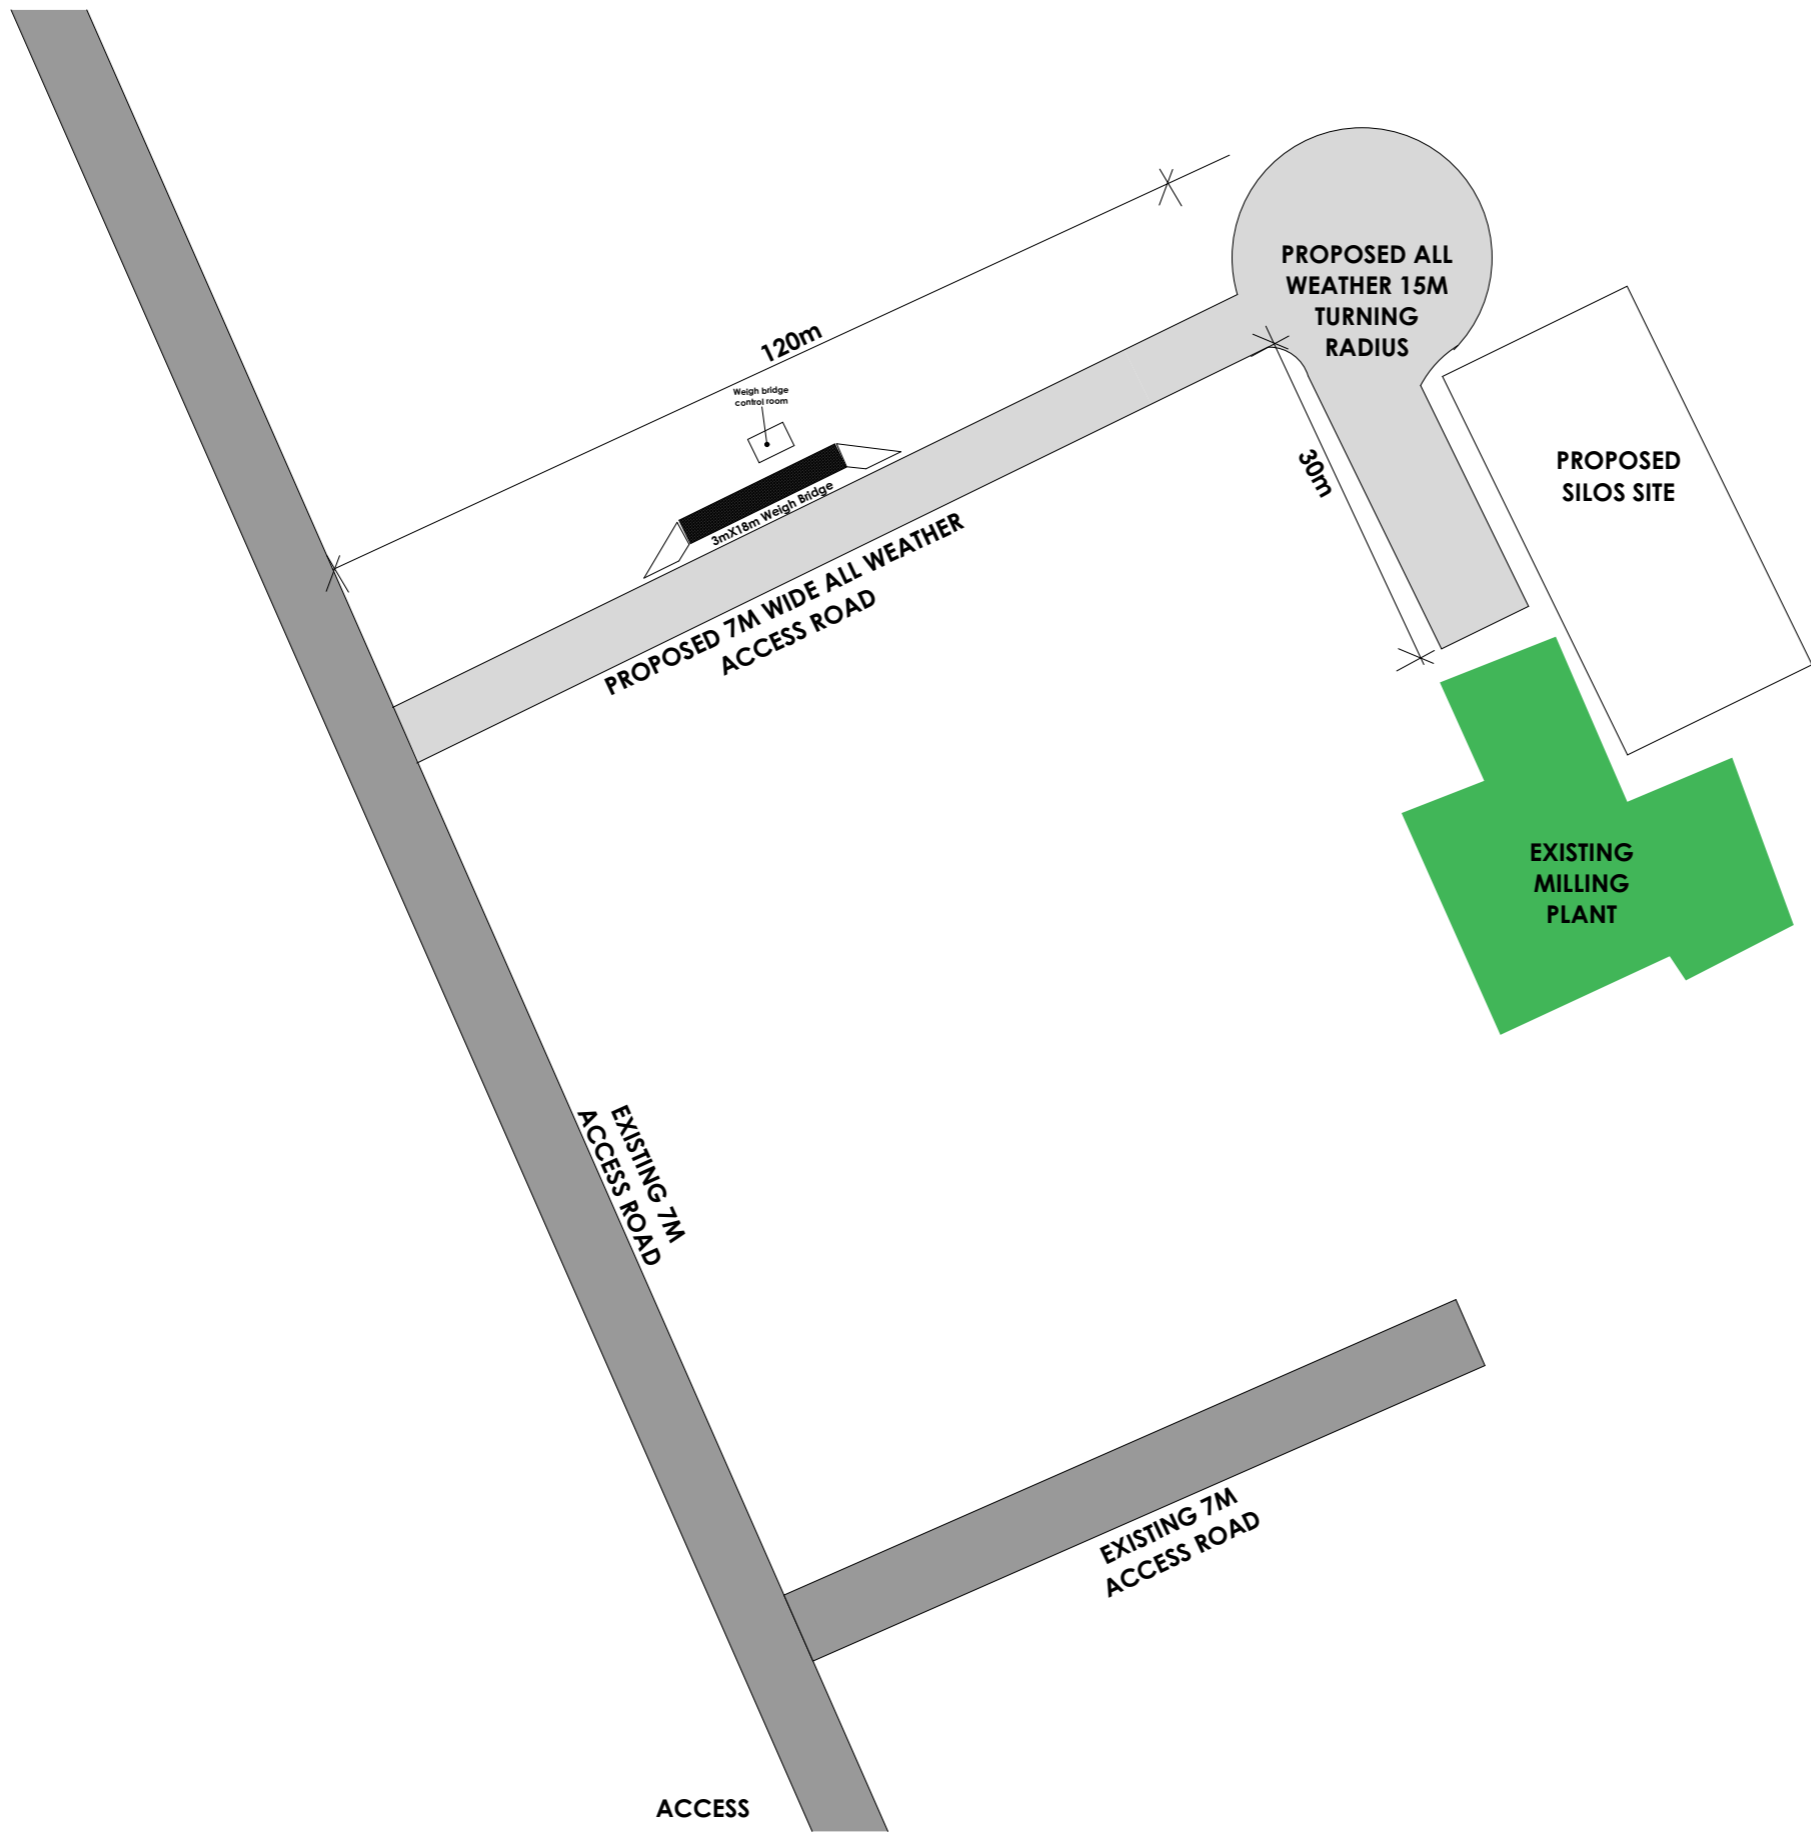

DEFENCE HEADQUARTERS
DHQ WORKS
ULINZI HOUSE
P.O BOX 40668
NAIROBI, KENYA

MASTER PLAN KOPC
SCALE: 1:872.58
DWG NO: A.01.2
REV:
DRWN: **Capt M Njau**
DATE: 09/03/2021

Quantity Surveyor
Capt Kinyati
Structural Engineer
Maj Githehu

Mechanical Engineer
Capt Wulu
Electrical Engineer
Maj Mutuku

CHECKED
-
PROJECT MANAGEMENT TEAM LEADER
PROJECT TITLE
PROPOSED DEVELOPMENT/AND IMPROVEMENTS AT

REVISIONS			
REV.	DATE	DESCRIPTION	BY

- GENERAL NOTES**
- All dimensions in millimetres (mm)
 - Do not scale off this drawing
 - All levels and dimensions to be checked on site before any building work commences
 - Any discrepancies to be reported to the office of the consultant
 - All work to be strictly in accordance with the standard specifications and notes
 - This drawing is to be read in conjunction with specifications and all other relevant drawings
 - Walls below 200mm thick to be reinforced with hoop iron at every alternate course
 - Depth of foundations to be decided on site
 - pv denotes permanent air vents over doors and windows as shown on drawings, FFL denotes finished floor level.
 - A single layer of 3-ply bituminous felt to be provided between masonry and r.c. work
 - Drain pipes passing under tarmac, driveways, and buildings to be encased in 150mm thick concrete surround
 - All reinforced concrete work to Structural Engineer's drawings
 - All sanitary works to the entire satisfaction of MoH
 - All roads, storm water drainage and foul sewerage to Civil Engineer's drawings